
PLANS FOR 2024 LAKE ICARIA RAW WATER PUMP STATION REPLACEMENT **CORNING MUNICIPAL UTILITIES** LAKE ICARIA, IOWA

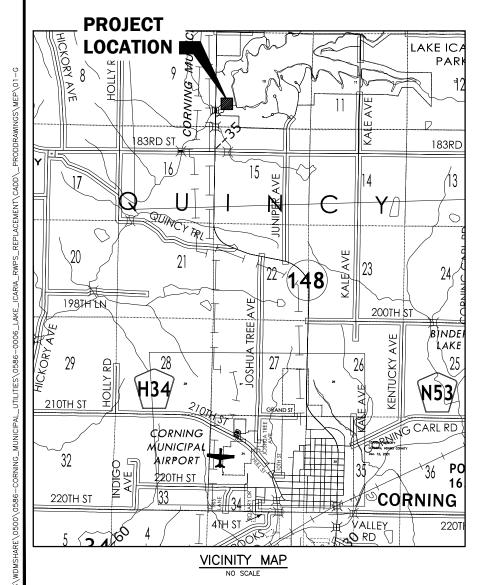

	DRAWING INDEX						
DWG. NO.	TITLE						
01-G-1 01-G-2	TITLE & INDEX SHEET LEGENDS						
02-C-1 02-C-2 02-C-3	SITE PLANS OVERALL EXISTING SITE PLAN REMOVAL SITE PLAN PROPOSED SITE PLAN						
	STRUCTURE 10 - PUMP STATION						
	PROCESS						
10-P-1 10-P-2	PLAN & SECTIONS SECTION						
10-E-1	ELECTRICAL ELECTRICAL PLAN						
	STANDARD DETAILS						
99-P-1	PROCESS PROCESS DETAILS						
	ELECTRICAL						
99-E-1 99-E-2 99-E-3 99-E-4	ELECTRICAL ONE-LINE DIAGRAM ELECTRICAL SCHEMATICS ELECTRICAL SCHEDULES ELECTRICAL DETAILS						

GENERAL NOTES

- ALL ELEVATIONS ARE TO NAD 83 (2011).
 ALL NORTHING AND EASTING COORDINATES ARE TO NAD 83, IOWA
 REGIONAL COORDINATES SYSTEM, ZONE 12.
 SHAPE ALL AREAS TO DRAIN AFTER CONSTRUCTION.
- CONFIRM LOCATION AND DEPTH OF ALL EXISTING UNDERGROUND UTILITIES AS REQUIRED TO ELIMINATE CONFLICTS PRIOR TO CONSTRUCTION, ALLOW UTILITY PERSONNEL TO RELOCATE UTILITIES WHERE CONFLICTS OCCUR.
- 5. DO NOT INTERRUPT EXISTING UTILITIES OR INDIVIDUAL SERVICES UNLESS
- DIRECTED BY ENGINEER.

 6. LOCATIONS OF CONSTRUCTION LIMIT LINES SHOWN ON PLANS ARE APPROXIMATE, ENGINEER WILL LOCATE CONSTRUCTION LIMITS IN FIELD CONFINE ALL CONSTRUCTION OPERATIONS, INCLUDING ACCESS TO WORK TO CONSTRUCTION LIMITS.
- 7. PROTECT UTILITY POLES, LINES AND APPURTENANCES NOT SHOWN FOR
- RESET ALL PROPERTY PINS DISTURBED BY CONSTRUCTION; PINS RESET
 BY REGISTERED LAND SURVEYOR; COST IS INCIDENTAL TO
- CONSTRUCTION.

 PROTECT ALL SURFACING, NOT INDICATED BY SHADING FOR REMOVAL AND REPLACEMENT FROM DAMAGE DURING CONSTRUCTION.

PROTECTION OF VEGETATION

TREES AND OTHER VEGETATION WHICH MAY BE REMOVED ARE MARKED WITH AN "X" OVER THE APPROPRIATE SYMBOL. FOR EXAMPLE & 12" INDICATES
THE REMOVAL OF A 12" TREE, REPLACEMENT, BY CONTRACTOR, OF THESE TIEMS IN NOT REQUIRED. TUNNEL, INSTALL TIGHT SHEETING, HAND EXCAVATE OR EMPLOY OTHER MEANS APPROVED BY ENGINEER TO PROTECT EXPOSED PORTIONS AND ROOT SYSTEMS OF TREES AND OTHER VEGETATION NOT SCHEDULED FOR REMOVAL. IF TREES AND OTHER VEGETATION NOT SCHEDULED FOR REMOVAL ARE DAMAGED DURING CONSTRUCTION, REPLACE IN KIND AND SIZE AT NO COST TO CITY OR PROPERTY OWNER.

1-800-292-8989



NAME: DATE:

April 9, 2024

MY LICENSE RENEWAL DATE IS DECEMBER 31, 2025 PAGES COVERED BY THIS SEAL: 01-G, 02-C, 10-P, 99-F

Faul)



HEREBY CERTIFY THAT THIS ENGINEERING DOCUMENT WAS PREPARED BY ME OR UNDER MY DIRECT PERSONAL SUPERVISION AND THAT I AM DULY LICENSED PROFESSIONAL ENGINEER UNDER THE LAWS OF THE STATE OF IOWA.

1 were

NAMF.

JACOB LUCAS. April 9, 2024 DATE:

MY LICENSE RENEWAL DATE IS DECEMBER 31, 2025 PAGES COVERED BY THIS SEAL: 10-E, 99-E



DATE	REVISIONS	SCALE	AS NOTED
		DRAWN	BSS
		CHECKED	MJS
		APPROVED	MJS
		DATE	4/9/2024
		ISSUED FOR	BIDDING




2024 LAKE ICARIA RAW WATER PUMP STATION REPLACEMENT CORNING, IOWA

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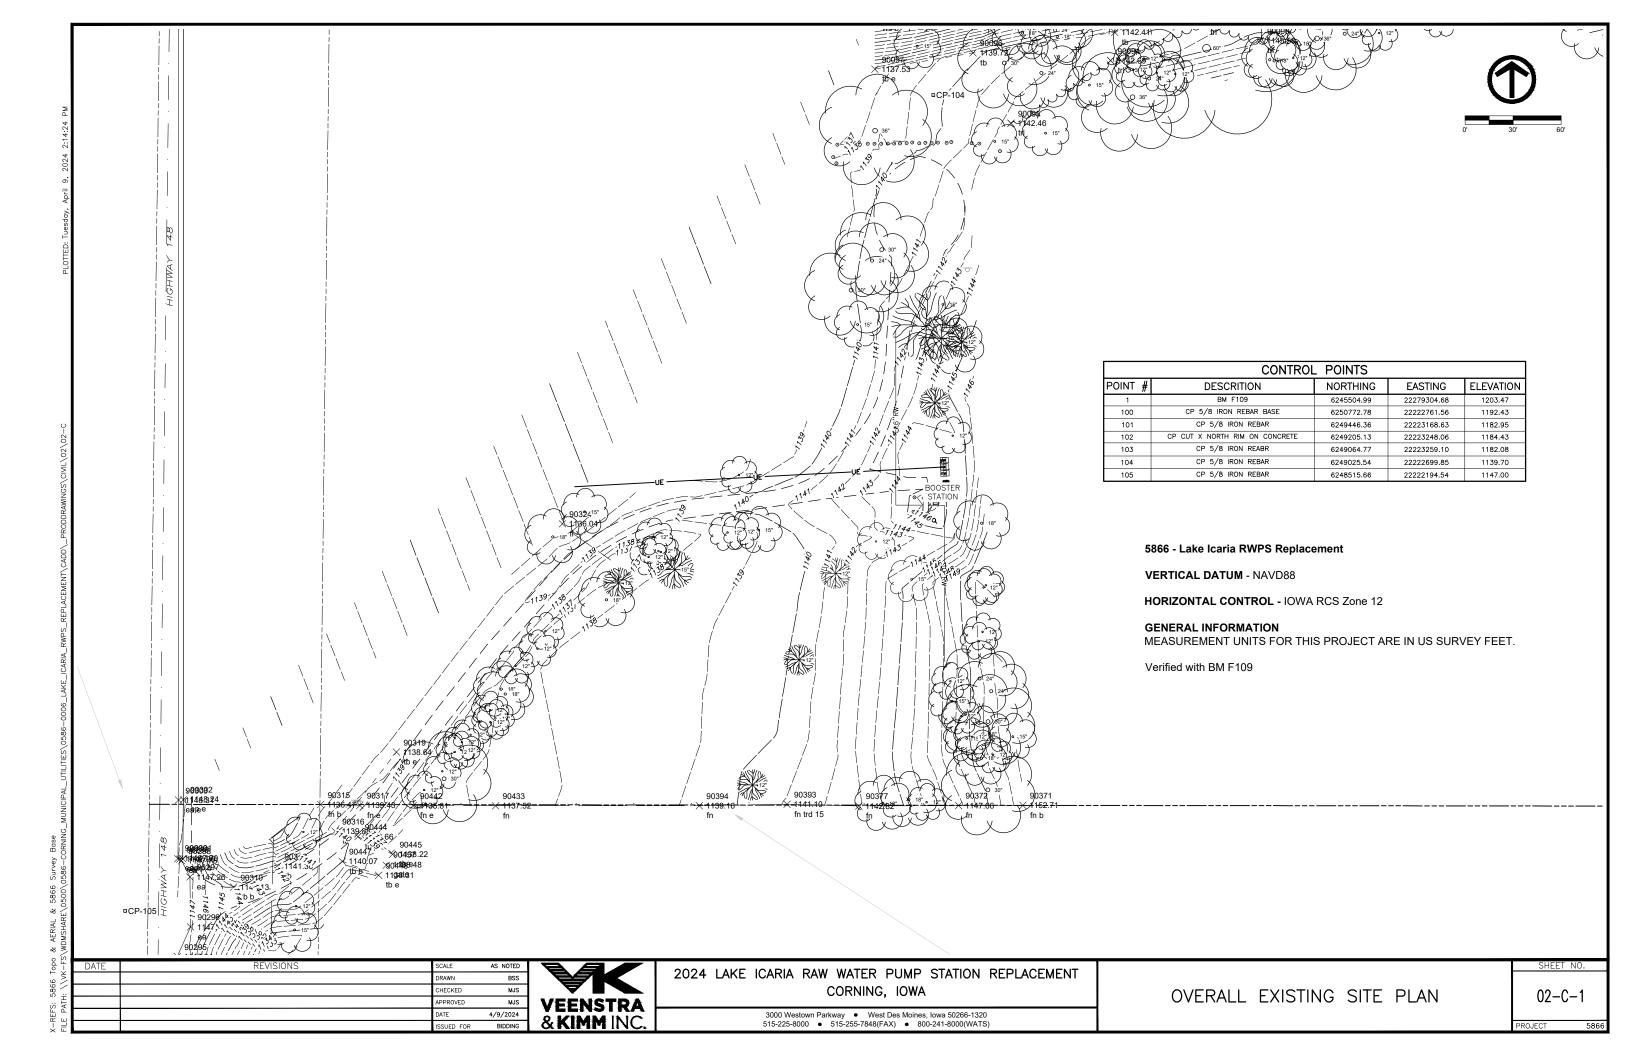
TITLE & INDEX SHEET


DWG, NO. 01-G-1

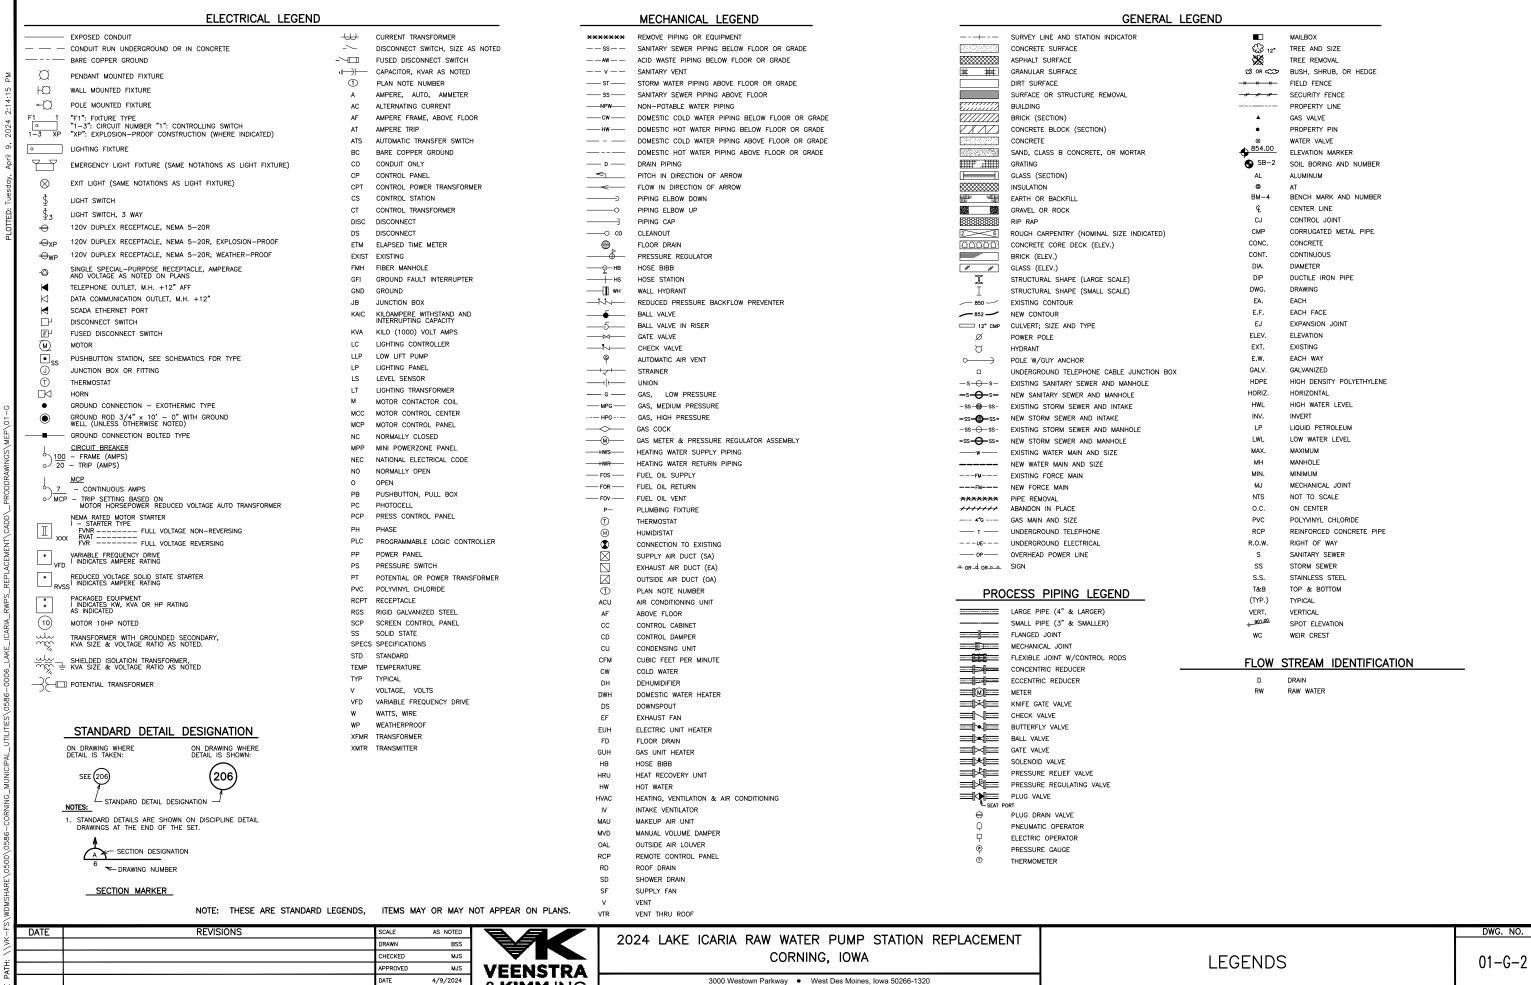



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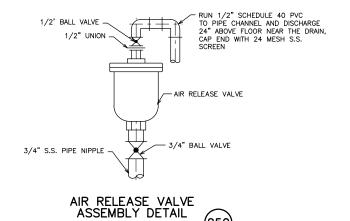
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NO SCALE

ANCHOR BOLT, PLACE IN SUSPENDED SLAB OR SLAB ON GRADE IF PAD IS OF INSUFFICIENT THICKNESS TO PROVIDE EMBEDMENT ∕ 3/4" CHAMFER -#5 @ 12" (TYP.) AS REQUIRED FOR EQUIPMENT AND PIPING (4" MIN.) - #5 @ 12" MIN. 4 PER BASE SUSPENDED SLAB OR SLAB ON GRADE, FOR THICKNESS SEE PLANS— - CONSTRUCTION JOINT LEAVE ROUGH AND CLEAN AND APPLY BONDING AGENT EQUIPMENT PAD DETAIL (309A) NO SCALE

SECTION D SCALE: 3/8" = 1'-0"

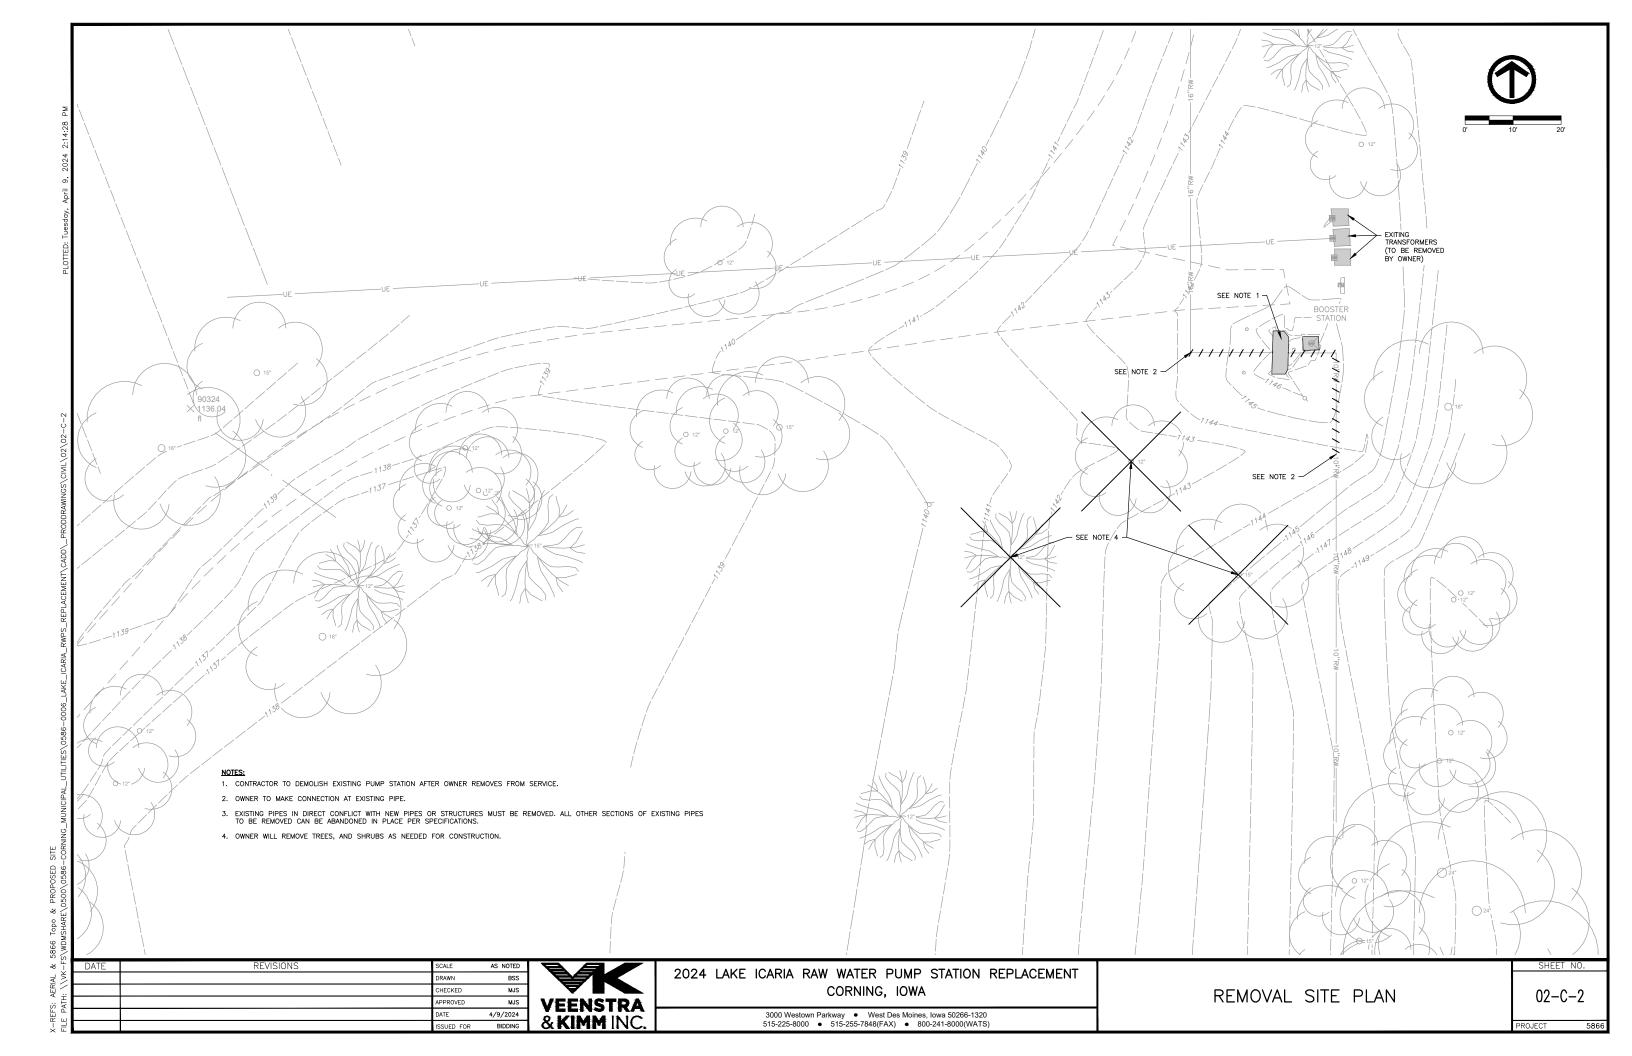	DATE	REVISIONS	SCALE	AS NOTED	Γ
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<u> </u>			CHECKED	MJS	ı
₽ H			APPROVED	MJS	1
E)			DATE	4/9/2024	ĺ
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VEENSTRA & KIMM INC.

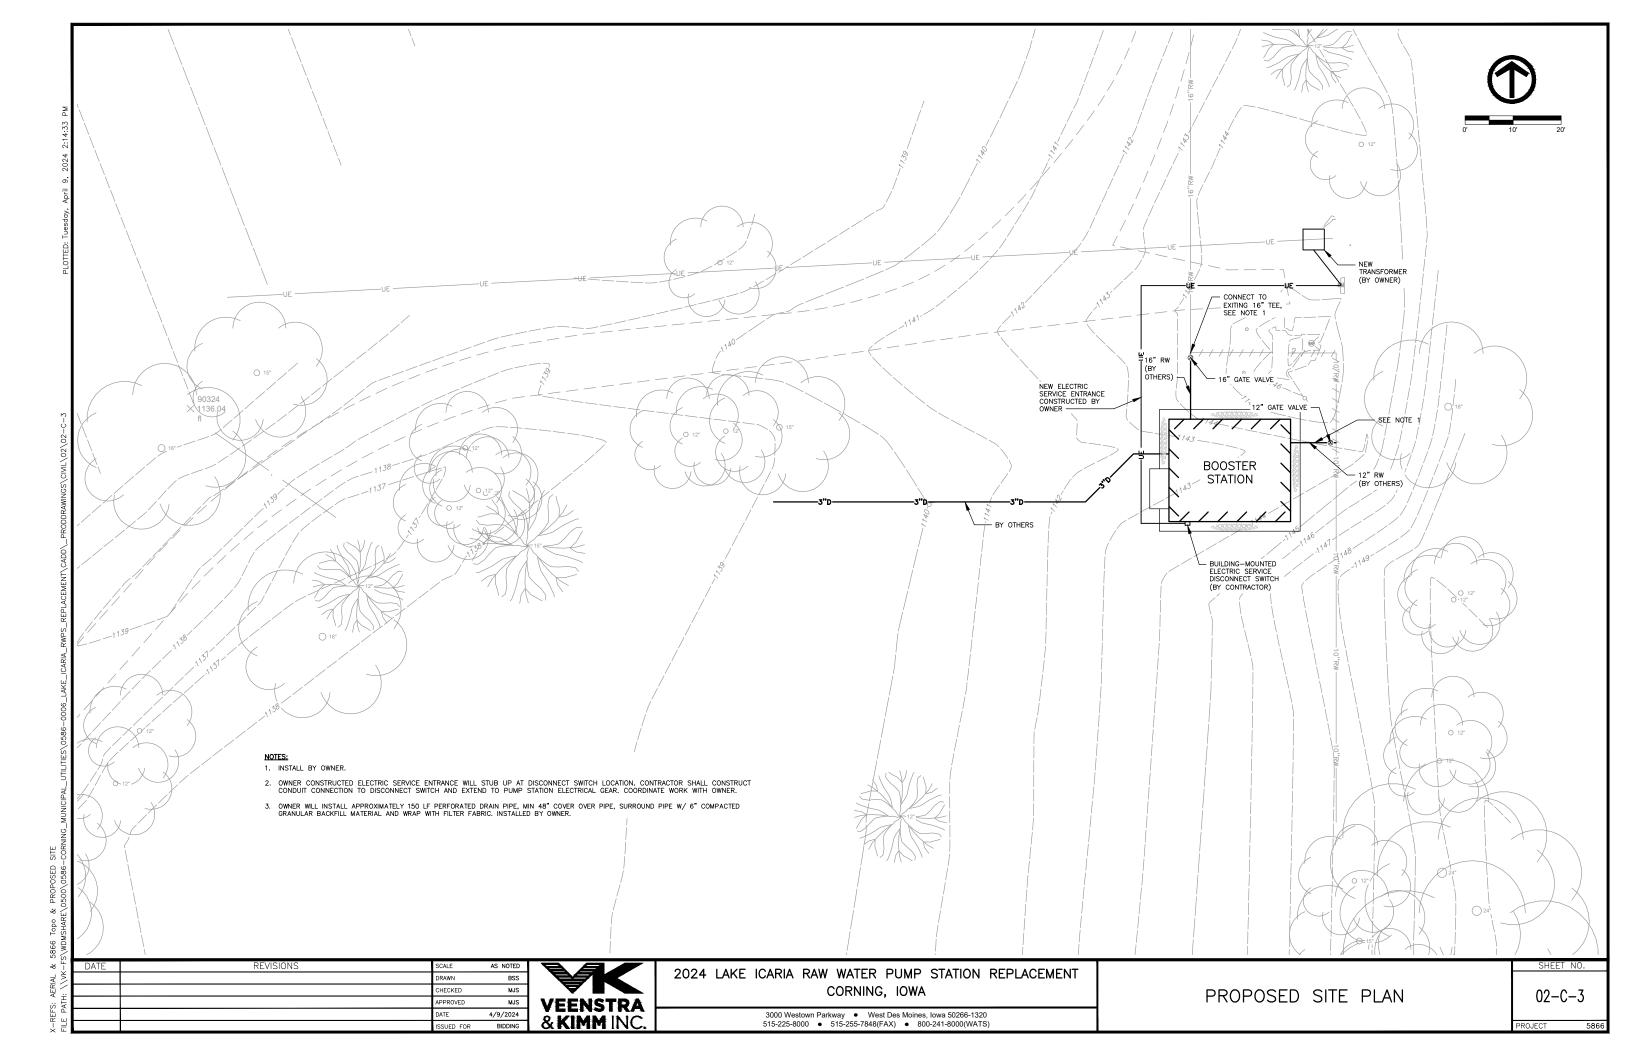
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PUMP STATION SECTION

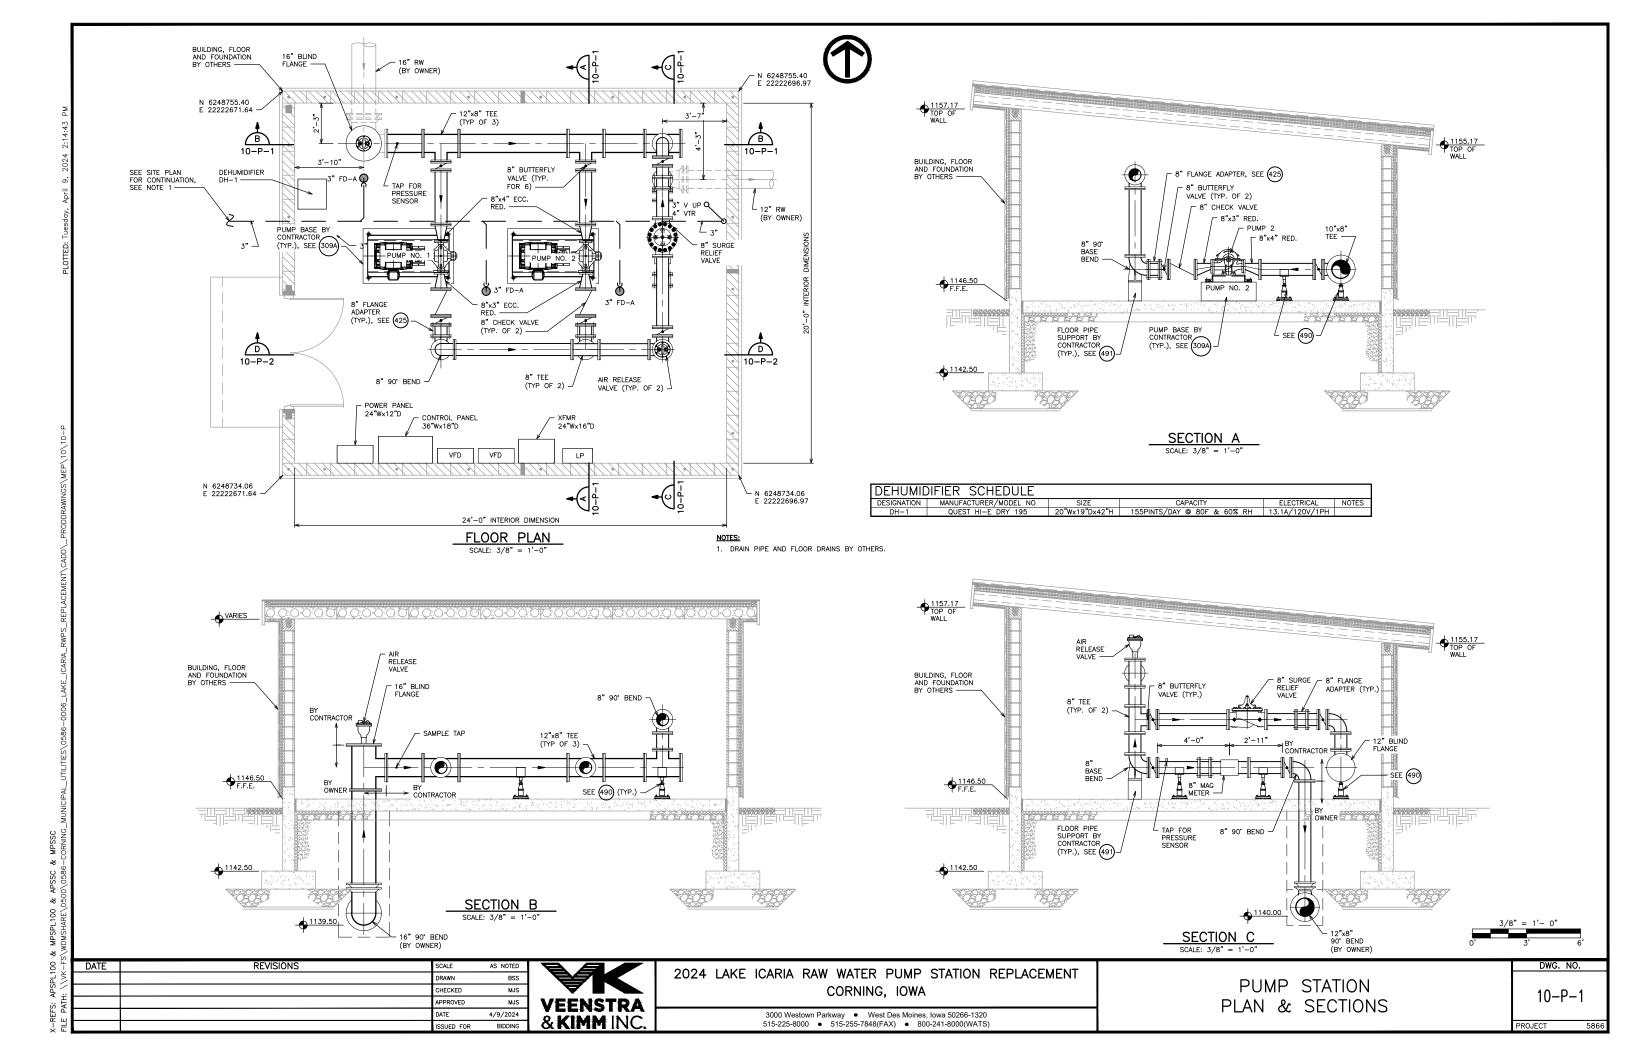PROJECT

	DWG. NO.
N	10-P-2



- 4. CONDUIT ROUTING IS DIAGRAMMATIC IN NATURE AND IS NOT INTENDED TO DICTATE EXACT ROUTING. CONTRACTOR IS TO DETERMINE BEST ROUTING BASED ON OTHER UTILITIES AND FIELD CONDITIONS.
- 5. CONTRACTOR TO VERIFY ACTUAL FIELD WIRING REQUIREMENTS WITH EQUIPMENT SUPPLIER. PROPER SEPARATION OF POWER AND CONTROL CIRCUITS SHALL BE MAINTAINED.
- 6. DRAWING DESIGNATIONS FOR LIGHTING PANEL LP-1 CIRCUITS ARE AS FOLLOWS, WITH X REPRESENTING THE CIRCUIT NUMBER: 1-X.
- 7. SOME EQUIPMENT AND INSTRUMENTS SHOWN OUT OF PLANE FOR CLARITY. REFER TO PROCESS SHEETS FOR SECTION VIEWS.
- 8. EMERGENCY LIGHT FIXTURE SHALL BE POWERED FROM LINE SIDE OF INTERIOR LIGHT SWITCH.
- 9. INTERIOR WIRING DEVICES SHALL BE MOUNTED AT 48" AFF

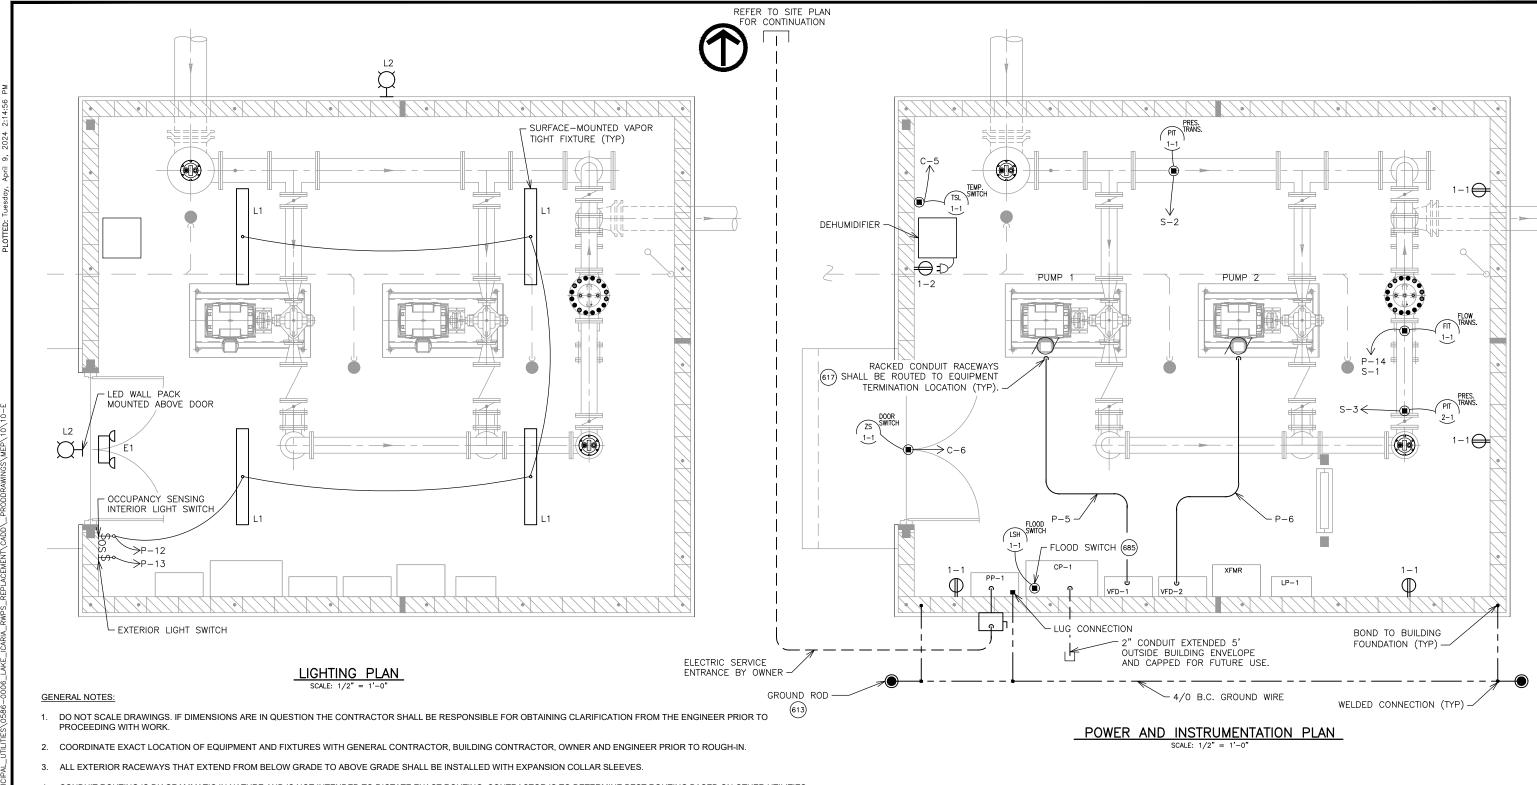F.	DATE	REVISIONS	SCALE	AS NOTED	
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ΑTΗ			APPROVED	JDL	,
E PA			DATE	4/9/2024	İ
Ξ.			ISSUED FOR	BIDDING	,



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PUMP STATION ELECTRICAL PLANS


10-E-1

PROJECT


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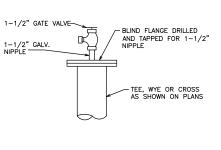







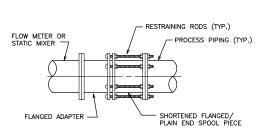



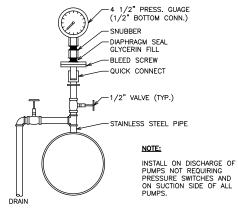




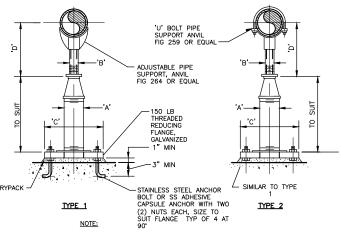


1. UNDER VALVES, METERS OR OTHER SPECIAL APPURTENANCES A FABRICATED SUPPORT PIECE MAY BE UTILIZED AS ACCEPTABLE TO ENGINEER

PIPE	SUPPORT	DETAIL	400
	NO SCALE	,	490

ADJUSTABLE PIPE SUPPORT APPROX DIMENSIONS IN INCHES						
PIPE SIZE	А	В	С	D MIN	D MAX	
2 1/2	2 1/2	1 1/2	9	8	11 1/2	
3	2 1/2	1 1/2	9	8 1/4	11 3/4	
3 1/2	2 1/2	1 1/2	9	8 1/2	12	
4	3	2 1/2	9	10 1/4	14	
6	3	2 1/2	9	11 5/8	15 1/4	
8	3	2 1/2	9	13 5/8	16 1/2	
10	3	2 1/2	9	14 5/8	18 1/4	
12	3	2 1/2	9	15 5/8	19 3/4	
14	4	3	11	18 5/8	20 3/4	
16	4	3	11	19 7/8	22 1/4	
18	6	3 1/2	13 1/2	21 1/4	24	
20	6	3 1/2	13 1/2	23 1/4	25 1/2	
24	6	4	13 1/2	26 1/2	28 1/4	
30	6	4	13 1/2	29 5/8	31 1/2	
32	6	4	13 1/2	30 5/8	32 3/4	
36	6	4	13 1/2	32 5/8	34 3/4	

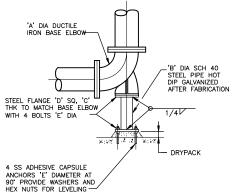


DUCTILE IRON BEND

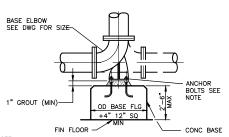

- NOTE:
- (4) STAINLESS STEEL 'E' DIA ANCHOR BOLTS WITH
 (2) S.S. HEX NUTS AND WASHERS
 FOR LEVELING AFTER INSTALLATION. SEE DETAIL
 (493)
 FOR 'E' DIAMETER

FLOOR SUPPORT DETAIL (491)

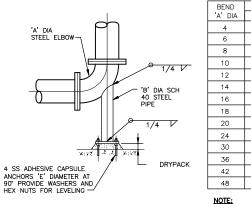


'A' DIA	'B' DIA	'C' THICK	'D' SQ	'E' DIA
4	2	3/8	6	5/8
6	2 1/2	3/8	7	5/8
8	4	1/2	9	5/8
10	4	1/2	9	5/8
12	6	1/2	11	3/4
14	6	1/2	11	3/4
16	6	1/2	11	3/4
18	8	1/2	13 1/2	3/4
20	8	1/2	13 1/2	3/4
24	8	1/2	13 1/2	3/4
30	10	3/4	16	7/8
36	12	3/4	19	7/8
42	16	3/4	23 1/2	1
48	18	3/4	25	1 1/8

DIMENSIONS IN INCHES

NOTE: 1. MATERIAL FINISH TO MATCH PIPE.

2. FOR CONSTRUCTION BEND SUPPORT SEE DETAIL (310)



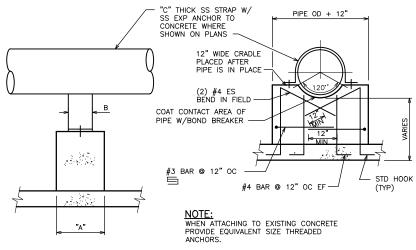

CONCRETE PIPE SUPPORT 495) NO SCALE

DATE	REVISIONS	SCALE	AS NOTED
		DRAWN	BSS
		CHECKED	MJS
		APPROVED	MJS
		DATE	4/9/2024
		ISSUED FOR	BIDDING




2024	LAKE	ICARIA	RAW	WATER	PUMP	STATION	REPLACEMENT
			C	ORNING	, IOWA		

PROCESS DETAILS

DWG. NO. 99-P-1

ROJECT

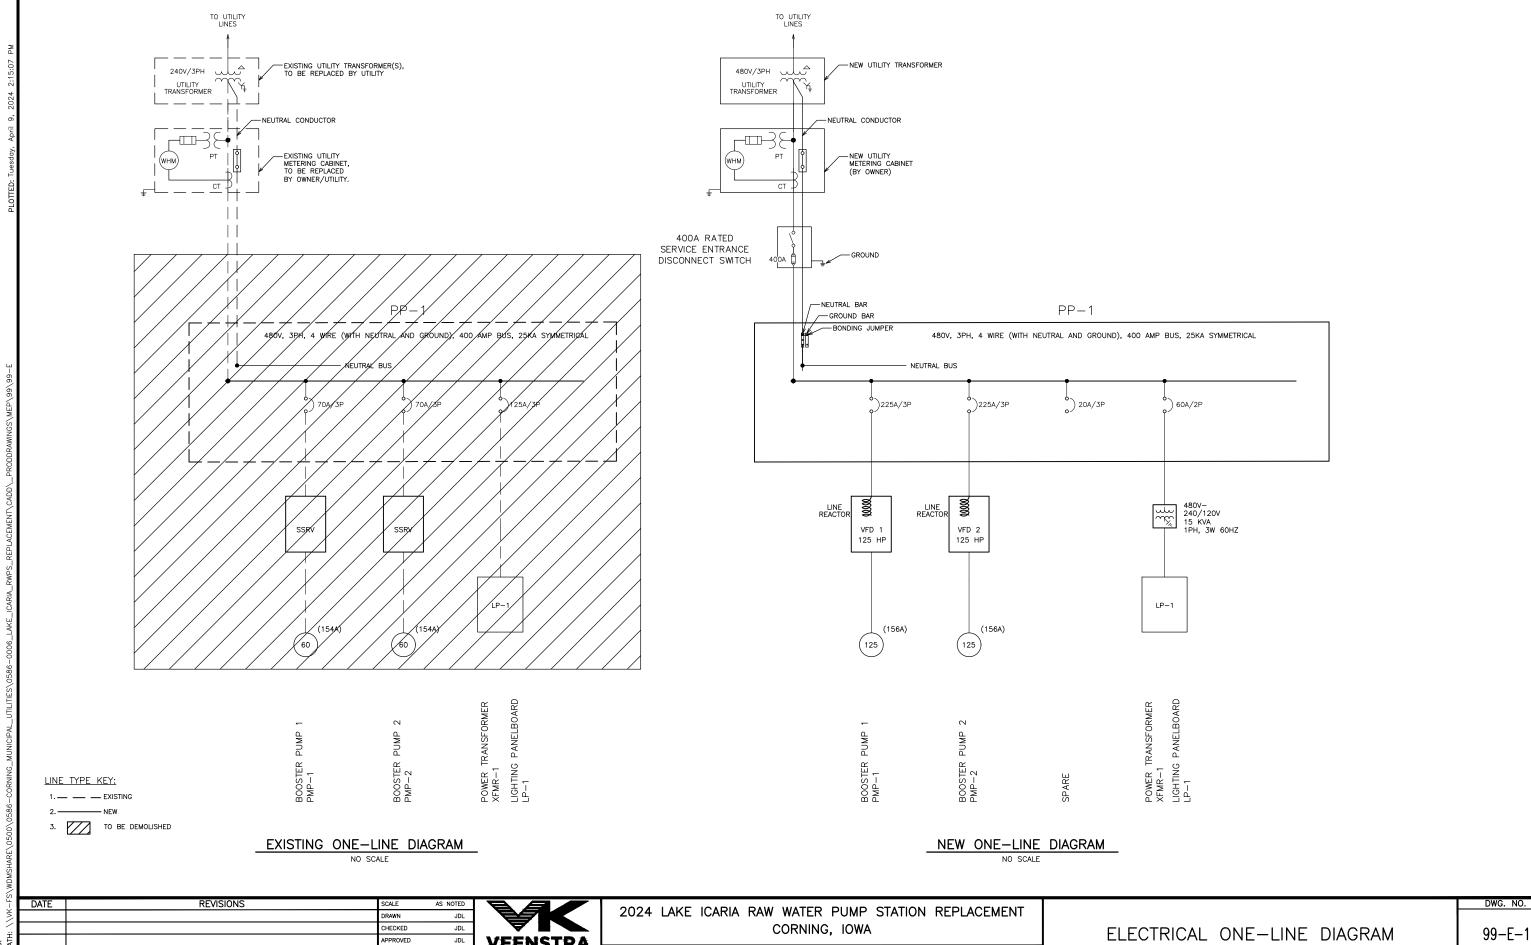


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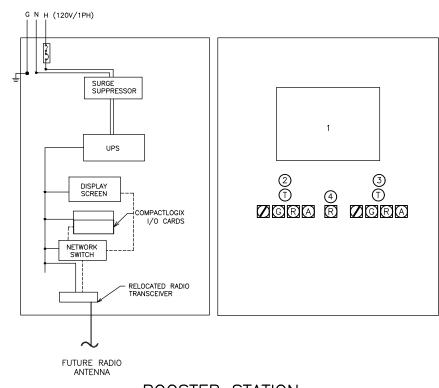
PROJECT

APPROVED

4/9/2024

& KIMM INC



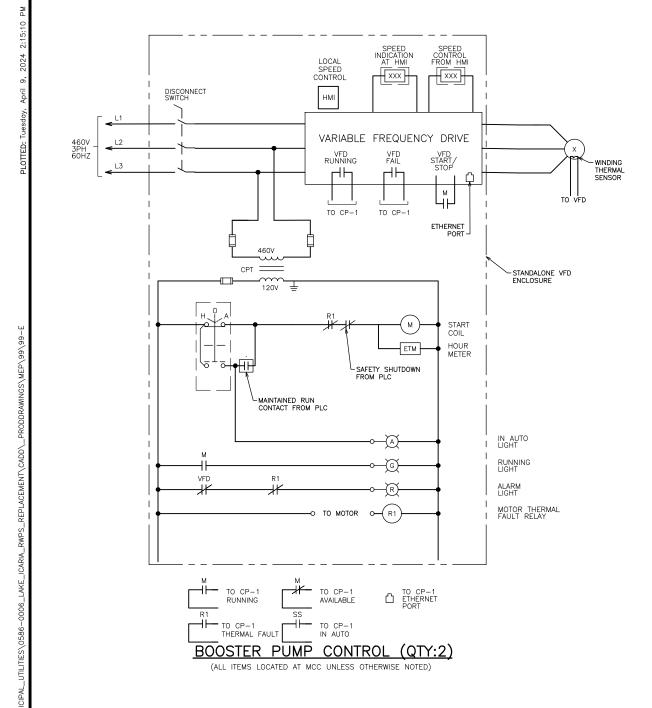

BOOSTER STATION SCADA CONTROL PANEL (CP-1)

SCALE: NONE

DESCRIPTION

PUMP #1 INDICATORS

PUMP #2 INDICATORS
BUILDING ALARM

CONTROL PANEL DISPLAY SCREEN

A IN AUTO

R ALARM

G RUNNING

H-O-A SWITCH W/ CONTACT BLOCK FOR PLC

T ELAPSED TIME METER

SIONS	SCALE	AS NOTED	
	DRAWN	JDL	
	CHECKED	JDL	
	APPROVED	JDL	
	DATE	4/9/2024	
	ISSUED FOR	BIDDING	ı



2024 LAKE ICARIA RAW WATER PUMP STATION REPLACEMENT CORNING, IOWA

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ELECTRICAL SCHEMATICS

99-E-2

DWG. NO.

LP-1 - BOOSTER STATION

120/240 VOLTS, 1 PHASE, 3 WIRE 100 AMP MAIN BREAKER									FEED:- 100A MOUNTING: SURFACE
LOAD	CKT	BREAKER	l	_1	L	.2	BREAKER	CKT	LOAD
INTERIOR REC.	1	1P-20A	3.0	10.0			1P-20A	2	DEHUMIDIFIER REC.
SPARE	3	1P-20A			2.0	1.0	1P-20A	4	FLOW METER
INTERIOR LIGHTS	5	1P-20A	2.0	2.0			1P-20A	6	EXTERIOR LIGHTS
SPARE	7	1P-20A					1P-20A	8	SPARE
SPARE	9	1P-20A			,	•		10	SPARE
SPACE	11							12	SPACE
SPACE	13							14	SPACE
HVAC EQUIP.	15	2P-30A					2P-30A	16	SPD
TIVAC EQUII.	17	21-30A					ZI-30A	18	310
					•		,		

RLA	5.0		2.0	
RLA		12.0		1.0
HIGH LEG	MCA	21.3		3.8
HIGH LEG	RLA	17.0		3.0
	RLA	17.0	MCA	21.3

CONE	DUIT	CONDUCTORS			NOTES
NO	SIZE	POWER	FROM	ТО	
P-1	(2) 3"	BY OTHERS	UTILITY TRANSFORMER	SERVICE ENTRANCE DISCONNECT SWITCH	1, 4
P-2	(2) 3"	TWO SETS OF 4#3/0 & 1#3 G.	SERVICE ENTRANCE DISCONNECT SWITCH	PP-1	1
P-3	3"	3#3/0 & 1#4 G.	PP-1	PUMP 1 VFD	1
P-4	3"	3#3/0 & 1#4 G.	PUMP 1 VFD	PUMP 1	1, 2
P-5	3"	3#3/0 & 1#4 G.	PP-1	PUMP 2 VFD	1
P-6	3"	3#3/0 & 1#4 G.	PUMP 2 VFD	PUMP 2	1, 2
P-7		NOT USED			
P-8	1"	2#8 & 1#10 G.	PP-1	POWER TRANSFORMER	1
P-9	1"	3#1 & 1#8 G.	POWER TRANSFORMER	LP-1	1
P-10	3/4"	2#12 & 1#12 G.	LP-1	INTERIOR REC.	1, 3
P-11		NOT USED			
P-12	3/4"	2#12 & 1#12 G.	LP-1	INTERIOR LIGHTS	1, 3
P-13	3/4"	2#12 & 1#12 G.	LP-1	EXTERIOR LIGHT	1, 3
P-14	3/4"	2#12 & 1#12 G.	LP-1	FLOW METER	1, 3
P-15	3/4"	2#12 & 1#12 G.	LP-1	DEHUMIDIFIER	1, 3
ALL "P-" CO	NDUITS MAY NOT E	BE SHOWN ON DRAWINGS; ROUTE CONDUITS A	ND WIRING AS PER THIS SCHEDULE.		

CON	IDUIT	CONDUCTORS	FROM	то	NOTES
NO SIZE		CONTROL	TROM	10	NOTES
C-1	2"	PULL STRING	CP-1		1, 2
C-2	3/4"	6#14	CP-1	VFD-1	1
C-3	3/4"	6#14	CP-1	VFD-2	1
C-4	3/4"	2#14	CP-1	FLOOD SWITCH	1
C-5	3/4"	2#14	CP-1	THERMOSTAT	1
C-6	3/4"	2#14	CP-1	DOOR SWITCH	1
LL "C-" CON	DUITS MAY NOT BE SH	HOWN ON DRAWINGS; ROUTE CONDUITS	AND WIRING AS PER THIS SCHEDULE.	·	•

	SIGNAL WIRING SCHEDULE	

			FROM	TO	NOTES		
NO	SIZE	SIGNAL	TIXOW	10	NOTES		
S-1	3/4"	2#14 & 1#18 TSP	CP-1	FIT 1-1	1, 2, 3		
S-2	3/4"	2#14 & 1#18 TSP	CP-1	PIT 1-1	1, 2, 3		
S-3	3/4"	2#14 & 1#18 TSP	CP-1	PIT 2-1	1, 2, 3		
S-4	3/4"	6#14 & 2#18 TSP	CP-1	VFD-1	1, 2, 3		
S-5	3/4"	6#14 & 2#18 TSP	CP-1	VFD-2	1, 2, 3		
. ALL "S-" CON	ALL "S-" CONDUITS MAY NOT BE SHOWN ON DRAWINGS; ROUTE CONDUITS AND WIRING AS PER THIS SCHEDULE.						

2. ALL SIGNAL CONDUITS SHALL BE PROVIDED WITH DEDICATED GROUND CONDUCTOR.

3. CONTRACTOR MAY ELECT TO CONSOLIDATE SIGNAL CONDUITS IF CONDUIT FILL CAPACITY IS NOT EXCEEDED.

	LIGHT FIXTURE SCHEDULE							
PLAN ID	BASIS OF DESIGN	LUMINAIRE DATA	VOLTAGE	NOTES				
L1	HOLOPHANE EMSL48 6000LM LPPFL WD MVOLT GZ10 40K OR EQUAL	48", 6,000 LUMEN, 37 WATT LED, LOW PROFILE POLYCARBONATE FROSTED LENS, DIMMABLE	120	1, 4				
L2	TRP2 24L-70 4K7 3 UNV DBT PC OR EQUAL	87W LED, TRAPEZOID, TYPE III DISTRIBUTION, BRONZE, 9' AG	120	1, 2, 3, 4				
F4	LITHONIA LHQM LED R HO	LED EXIT SIGN, SINGLE FACE, RED	400	1.4				
E1	OR EQUAL	LED EXIT SIGN, SINGLE PACE, RED	120	1, 4				
NOTES:	OTES:							

. SURFACE-MOUNT FIXTURE AT HEIGHT NOTED IN THE PLANS OR AS REQUIRED TO FIT THE APPLICATION.

2. FURNISH FIXTURE WITH PHOTO CELL AND WIRE IN SERIES WITH SWITCH.

3. SHALL BE DESIGNED TO OPERATE IN COLD TEMPERATURES.

4. FURNISH WITH MOUNTING HARDWARE

S				
4	DATE	REVISIONS	SCALE	AS NOTED
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~ ;			CHECKED	JDL
PATH			APPROVED	JDL
E P			DATE	4/9/2024
⊒			ISSUED FOR	BIDDING

3. CONTRACTOR MAY ELECT TO CONSOLIDATE POWER CONDUITS AS LONG AS CONDUIT FILL CAPACITIES ARE NOT EXCEEDED.




2024 LAKE ICARIA RAW WATER PUMP STATION REPLACEMENT CORNING, IOWA


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ELECTRICAL SCHEDULES


99-E-3


DWG. NO.



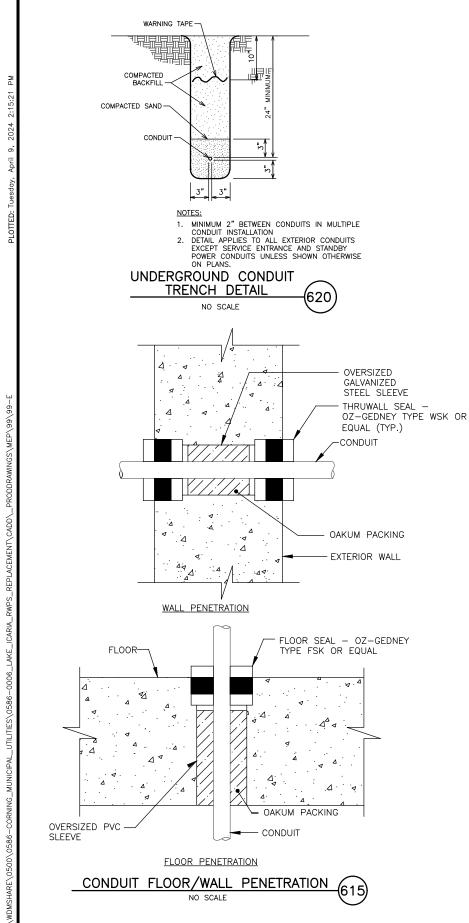


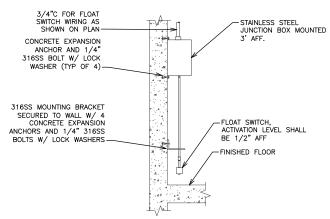FLOOD SWITCH DETAIL NO SCALE

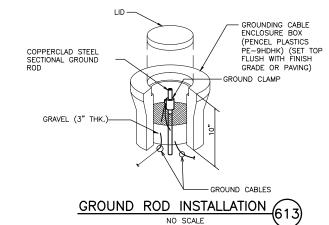

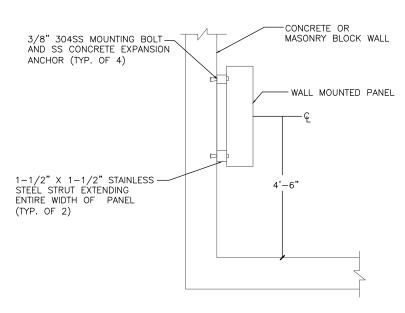




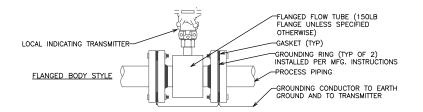

- NOTES
 1. INSTALL FLOW METER TO MAINTAIN STRAIGHT RUN OF 5 UPSTREAM PIPE DIAMETERS AND 2 DOWNSTREAM PIPE DIAMETERS, MINIMUM.
 2. INSTALL TWO CONDUITS BETWEEN FLOW TRANSMITTER AND CONTROL PANEL, AS REQUIRED, ALL CABLES AND GROUND CONDUCTORS SHALL BE INSTALLED IN CONDUIT.
 3. GROUNDING SYSTEM SHALL PROVIDE LESS THAN 0.5 OHM, 100MV WHEN TESTED WITH STANDARD METHODS.

ELECTRO-MAGNETIC FLOW METER INSTALLATION (680) SCALE: NONE

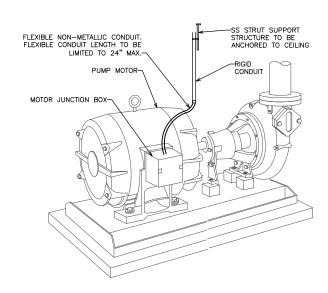

PUMP MOTOR POWER CONNECTION NO SCALE

١.				
-	DATE	REVISIONS	SCALE	AS NOTED
			DRAWN	JDL
			CHECKED	JDL
-			APPROVED	JDL
-			DATE	4/9/2024
ij			ICCUED FOR	BIDDING



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ELECTRICAL DETAILS

DWG. NO. 99-E-4